

1 SITE PLAN  
1/8" = 1'-0"


**SITE STATISTICS**  
 LOT AREA: 2072.95 sq.ft.  
 EXISTING FOOTPRINT: 603.96 sq.ft.  
 SUNROOM ADDITION: 147.55 sq.ft. ( m<sup>2</sup>)  
 TOTAL FOOTPRINT: 1184.00 sq.ft.  
 COVERAGE: 32.29%



Zhao, Wendy & Victor Savkin  
 30 Galt Ave. Toronto,  
 ON M4M 2Z1

| No. | Description | Date |
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| SITE PLAN          |                |             |
|--------------------|----------------|-------------|
| Project number     | Project Number | <b>A100</b> |
| Date               | 2020.12.15     |             |
| Drawn by           | Author         |             |
| Checked by         | Checker        |             |
| Scale 1/8" = 1'-0" |                |             |

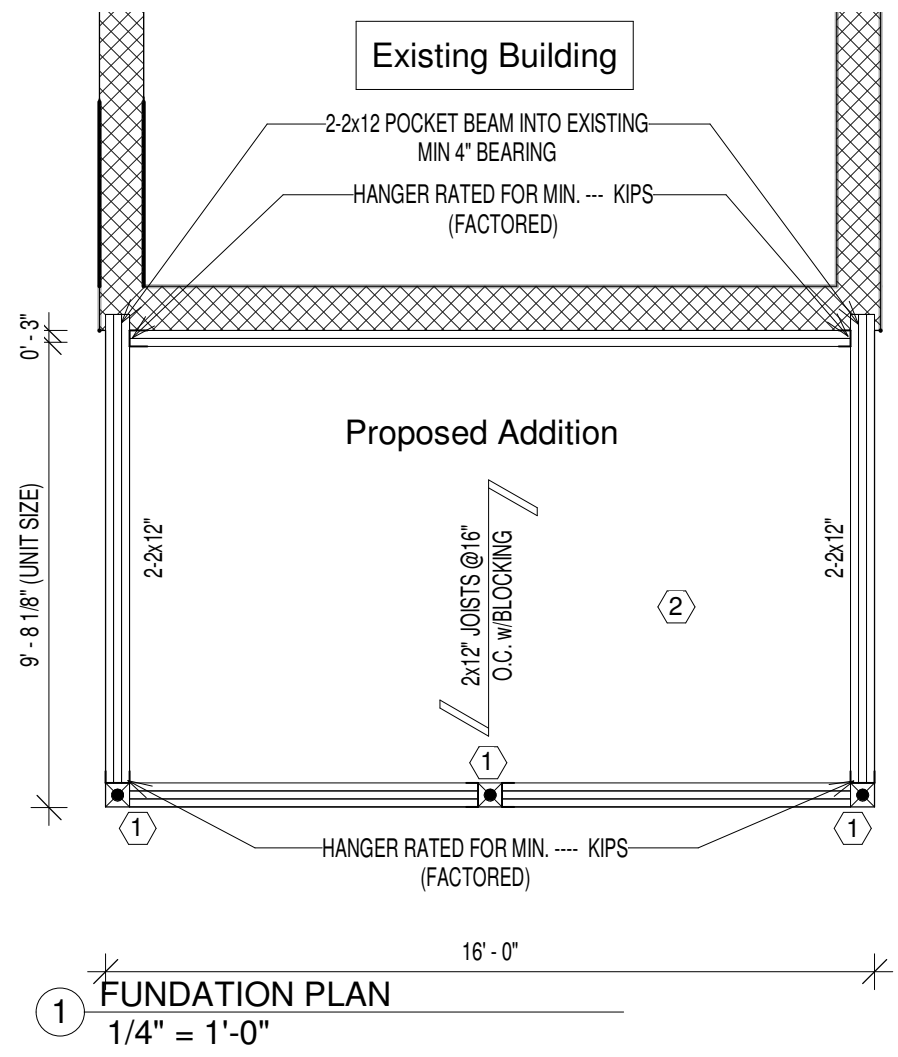

## NOTES

- 1 **TECHNO POST FOUNDATION**  
 TECHNO METAL POST (AS PER ENGINEERED DRAWINGS INCLUDED)  
 HELICAL PILE FOUNDATION SYSTEM -CCMC APPROVED  
 MODEL #P2 - 2 3/8" DIA. POST  
 MINIMUM 4'-0" BELOW GRADE ON UNDISTURBED GROUND  
 MINIMUM 6" ABOVE GRADE - TYPICAL  
 HELIX TO BE DETERMINED AT TIME OF INSTALLATION

### INSTALLATION

INSTALLATION TO BE UNDERTAKEN IN SUCH A MANNER SO AS TO PREVENT DAMAGE TO EXISTING STRUCTURES, ADJACENT PROPERTY AND UTILITIES. GRADE TO REMAIN THE SAME.

- 2 **FLOOR DECK**  
 5/8" T&G PLYWOOD SUB FLOOR GLUE AT JOINTS FOR VAPOUR BARRIER  
 SCREWED & GLUED TO JOISTS SUB FLOOR HEIGHT  
 2x12 FLOOR JOIST @ 16" O.C.  
 R31- R 39 INSULATION / VAPOUR BARRIER  
 1/2" SHEATHING UNDERNEATH  
 2 - 2 x 12 WOOD BEAM  
 BEAM TO BE UNDER FLOOR  
 WITH P.T. 6x6 POSTS AND 2x6 BRACING  
 FASTENED TO TECHNO POST WITH STEEL SADDLE  
 JOIST FASTENED WITH METAL JOIST HANGERS  
 ALL JOISTS WITH BRIDGING @ MAX. 6'-11"  
 2 - 2 x 10 STRINGER BOLTED WITH 1/2" EXPANSION BOLTS @ 20" O.C. TO EXISTING FOUNDATION



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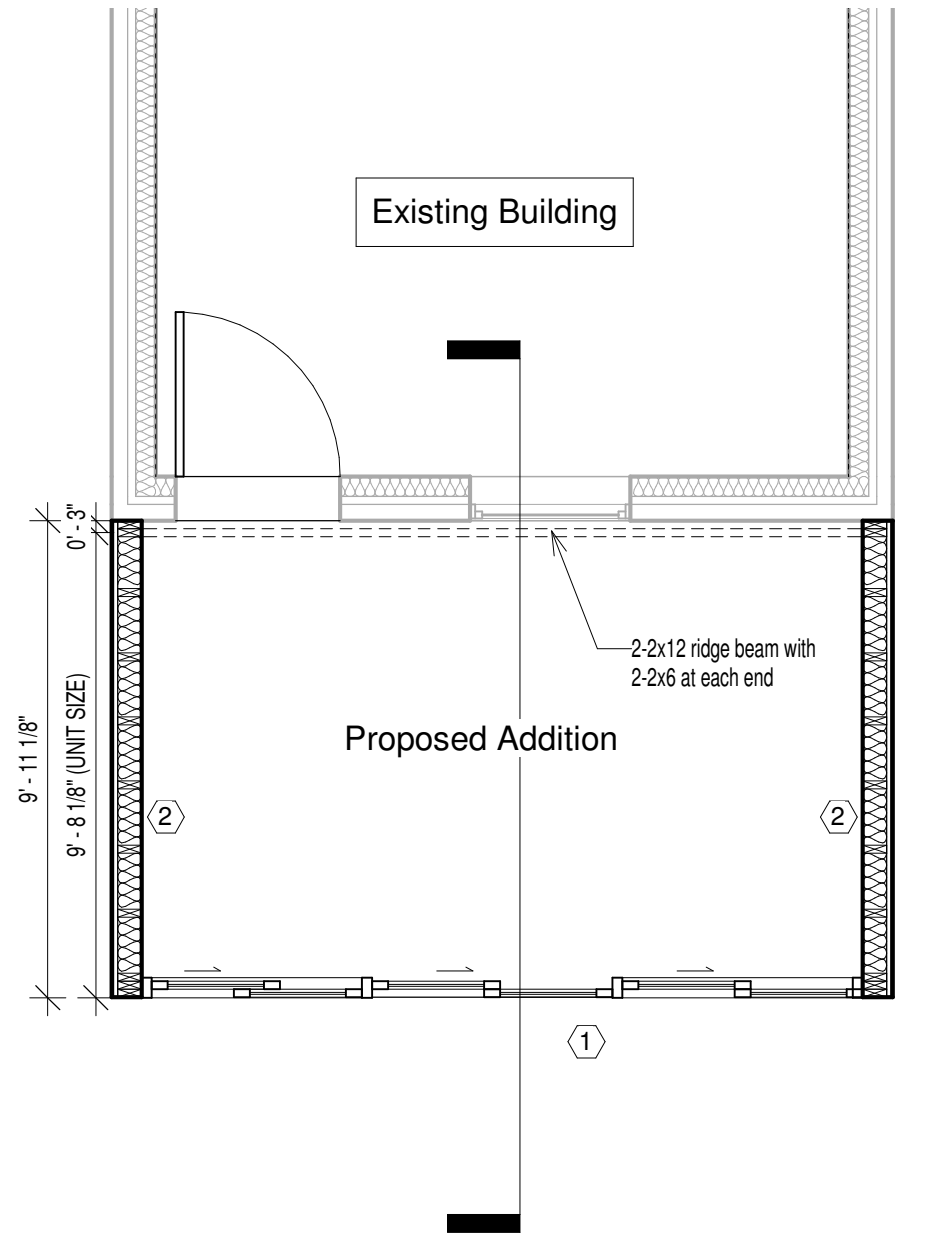
## FUNDATION PLAN

|                |                |              |
|----------------|----------------|--------------|
| Project number | Project Number | <b>A101</b>  |
| Date           | 2020.12.15     |              |
| Drawn by       | Author         |              |
| Checked by     | Checker        |              |
| Scale          |                | 1/4" = 1'-0" |

# NOTES

① **VERTICAL GLAZING**  
 DOORS & WINDOWS- RESISTANCE TO FORCED ENTRY  
 AND AS TO O.B.C. DIV. B, 9.7.2. & 9.7.3. \* 9.7.4. & 9.7.6.  
 7E HIGH PERFORMANCE GLAZING  
 TO BE CONSERVAGLASS (MC-7E)  
 MULTI-COAT GLAZING TECHNOLOGY (CODE 7E)  
 EASY-CLEAN II EXTERIOR COATING + STAY-CLEAN  
 TECHNOLOGY  
 ARGON GAS FILLED FOR BETTER INSULATION  
 75% REDUCTION IN TOTAL SOLAR TRANSMITTANCE  
 HIGH VISIBLE TRANSMITTANCE  
 R 4.0/ U 0.25 CENTER OF GLASS INSULATION VALUE  
 STAINLESS STEEL CONTINUOUS BENT SPACERS  
 DUAL POLY- ISOBUTYLENE AND SILICONE SEALS  
 FULLY TEMPERED INSULATED SAFETY GLASS  
 PROTECTIVE GLASS MASKING

② **BASEWALL/ SOLID WALLS**  
 WALL STUDS TO BE 2x6 ON 16" CENTERS  
 R20 BATT INSULATION w. R10ci w. 6 MIL VAPOUR BARRIER  
 1/2" DRYWALL TAPED, SANDED, PRIMED WHITE READY FOR PAINT  
 1/2" PLYWOOD EXTERIOR SHEATHING WITH TYVEK BUILDING PAPER  
 HORIZONTAL VINYL SIDING TO BE APPLIED TO EXTERIOR




① FIRST FLOOR  
 1/4" = 1'-0"



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| FLOOR PLAN     |                |              |
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| Project number | Project Number | <b>A102</b>  |
| Date           | 2020.12.15     |              |
| Drawn by       | Author         |              |
| Checked by     | Checker        |              |
| Scale          |                | 1/4" = 1'-0" |



## NOTES

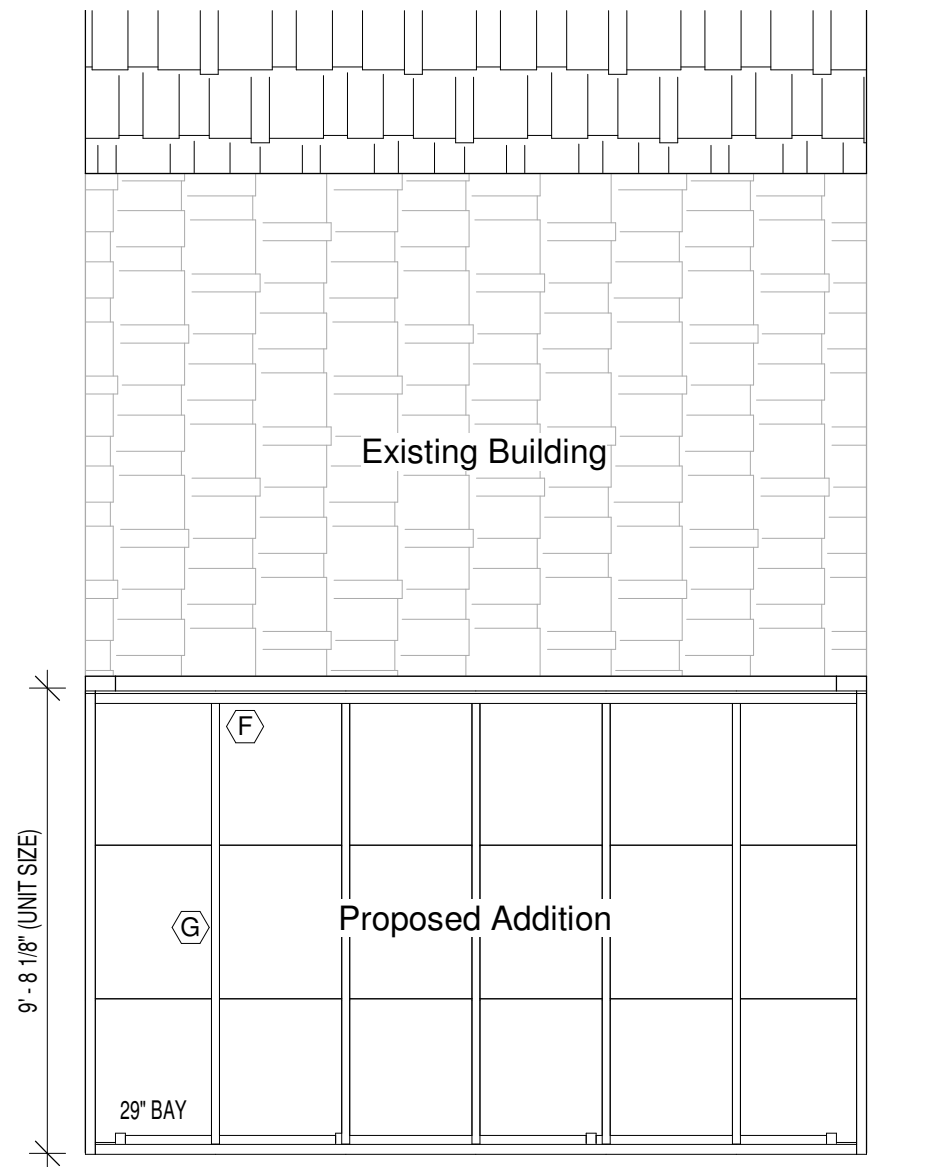- G** ROOF GLAZING  
 CODE 78 HIGH PERFORMANCE GLAZING  
 TO BE CONSERVAGLASS (MC-16)  
 EASY-CLEAN II EXTERIOR COATING + STAY-CLEAN TECHNOLOGY  
 ARGON GAS FILLED FOR BETTER INSULATION  
 90% REDUCTION IN TOTAL SOLAR TRANSMITTANCE  
 HIGH VISIBLE TRANSMITTANCE  
 R 4.0/ U 0.25 CENTER OF GLASS INSULATION VALUE  
 STAINLESS STEEL CONTINUOUS BENT SPACERS  
 DUAL POLY-ISOBUTYLENE AND SILICONE SEALS  
 FULLY TEMPERED INSULATED SAFETY GLASS  
 PROTECTIVE GLASS MASKING
- F** FLASHING  
 ALUM. FLASHINGS @ SILICONE SEALANT AT RIDGE MIN. 0.48mm  
 THICK ALUM. COATED FLASHING SEAL AT SUNROOM RIDGE

Snow: --- PSF (--- kPa)  
Wind: --- PSF (--- kPa)

① ROOF PLAN  
 1/4" = 1'-0"



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| ROOF PLAN      |                |                    |
|----------------|----------------|--------------------|
| Project number | Project Number | <b>A103</b>        |
| Date           | 2020.12.15     |                    |
| Drawn by       | Author         |                    |
| Checked by     | Checker        |                    |
|                |                | Scale 1/4" = 1'-0" |

# GLAZED OPENING CALCULATIONS

PER O.B.C TABLE 9.10.15.4

Front Elevation


| # | WIDTH    | DEPTH | WINDOW/DOOR<br>FRAME SIZE(S.F.) |
|---|----------|-------|---------------------------------|
| 1 | Existing |       | 23.00                           |
| 2 | New      |       | 111.05                          |

## Spatial Calculations

|                        |        |      |
|------------------------|--------|------|
| Exposing Building Face | 353.10 | S.F. |
|                        | 32.80  | S.M. |

Portion Wall Area

|                   |              |
|-------------------|--------------|
| Limiting Distance | 36' 2 17/32" |
| Max. % Openings   | 100 %        |
| Openings Allowed  | 353.10 S.F.  |
| Openings provided | 134.05 S.F.  |

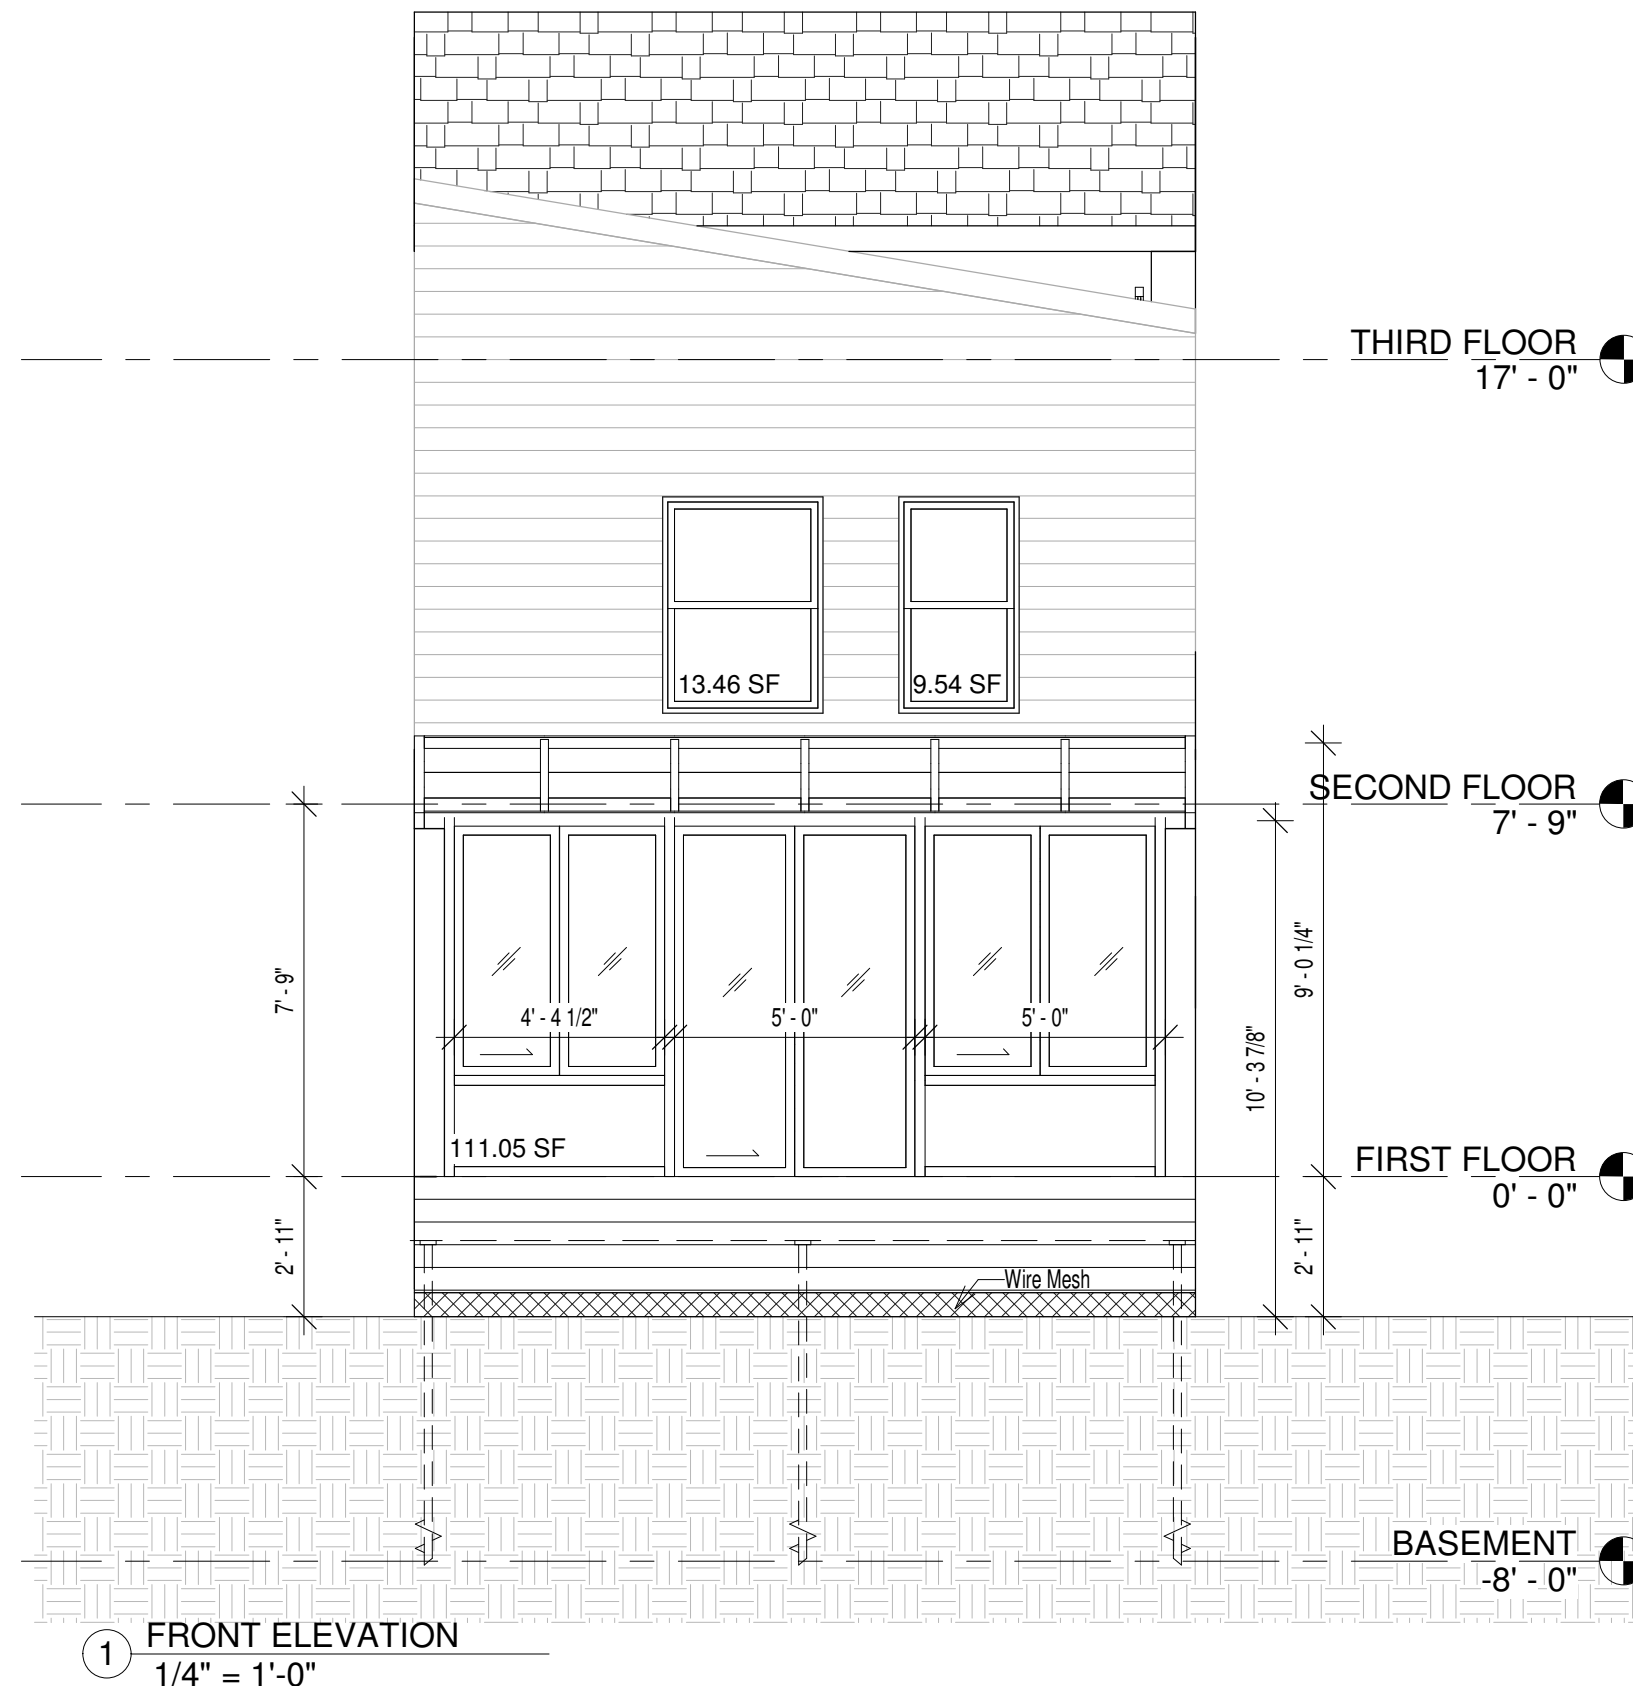

1 FRONT ELEVATION  
1/4" = 1'-0"




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## FRONT ELEVATION

|                    |                |             |
|--------------------|----------------|-------------|
| Project number     | Project Number | <b>A104</b> |
| Date               | 2020.12.15     |             |
| Drawn by           | Author         |             |
| Checked by         | Checker        |             |
| Scale 1/4" = 1'-0" |                |             |



1 RIGHT ELEVATION  
1/4" = 1'-0"

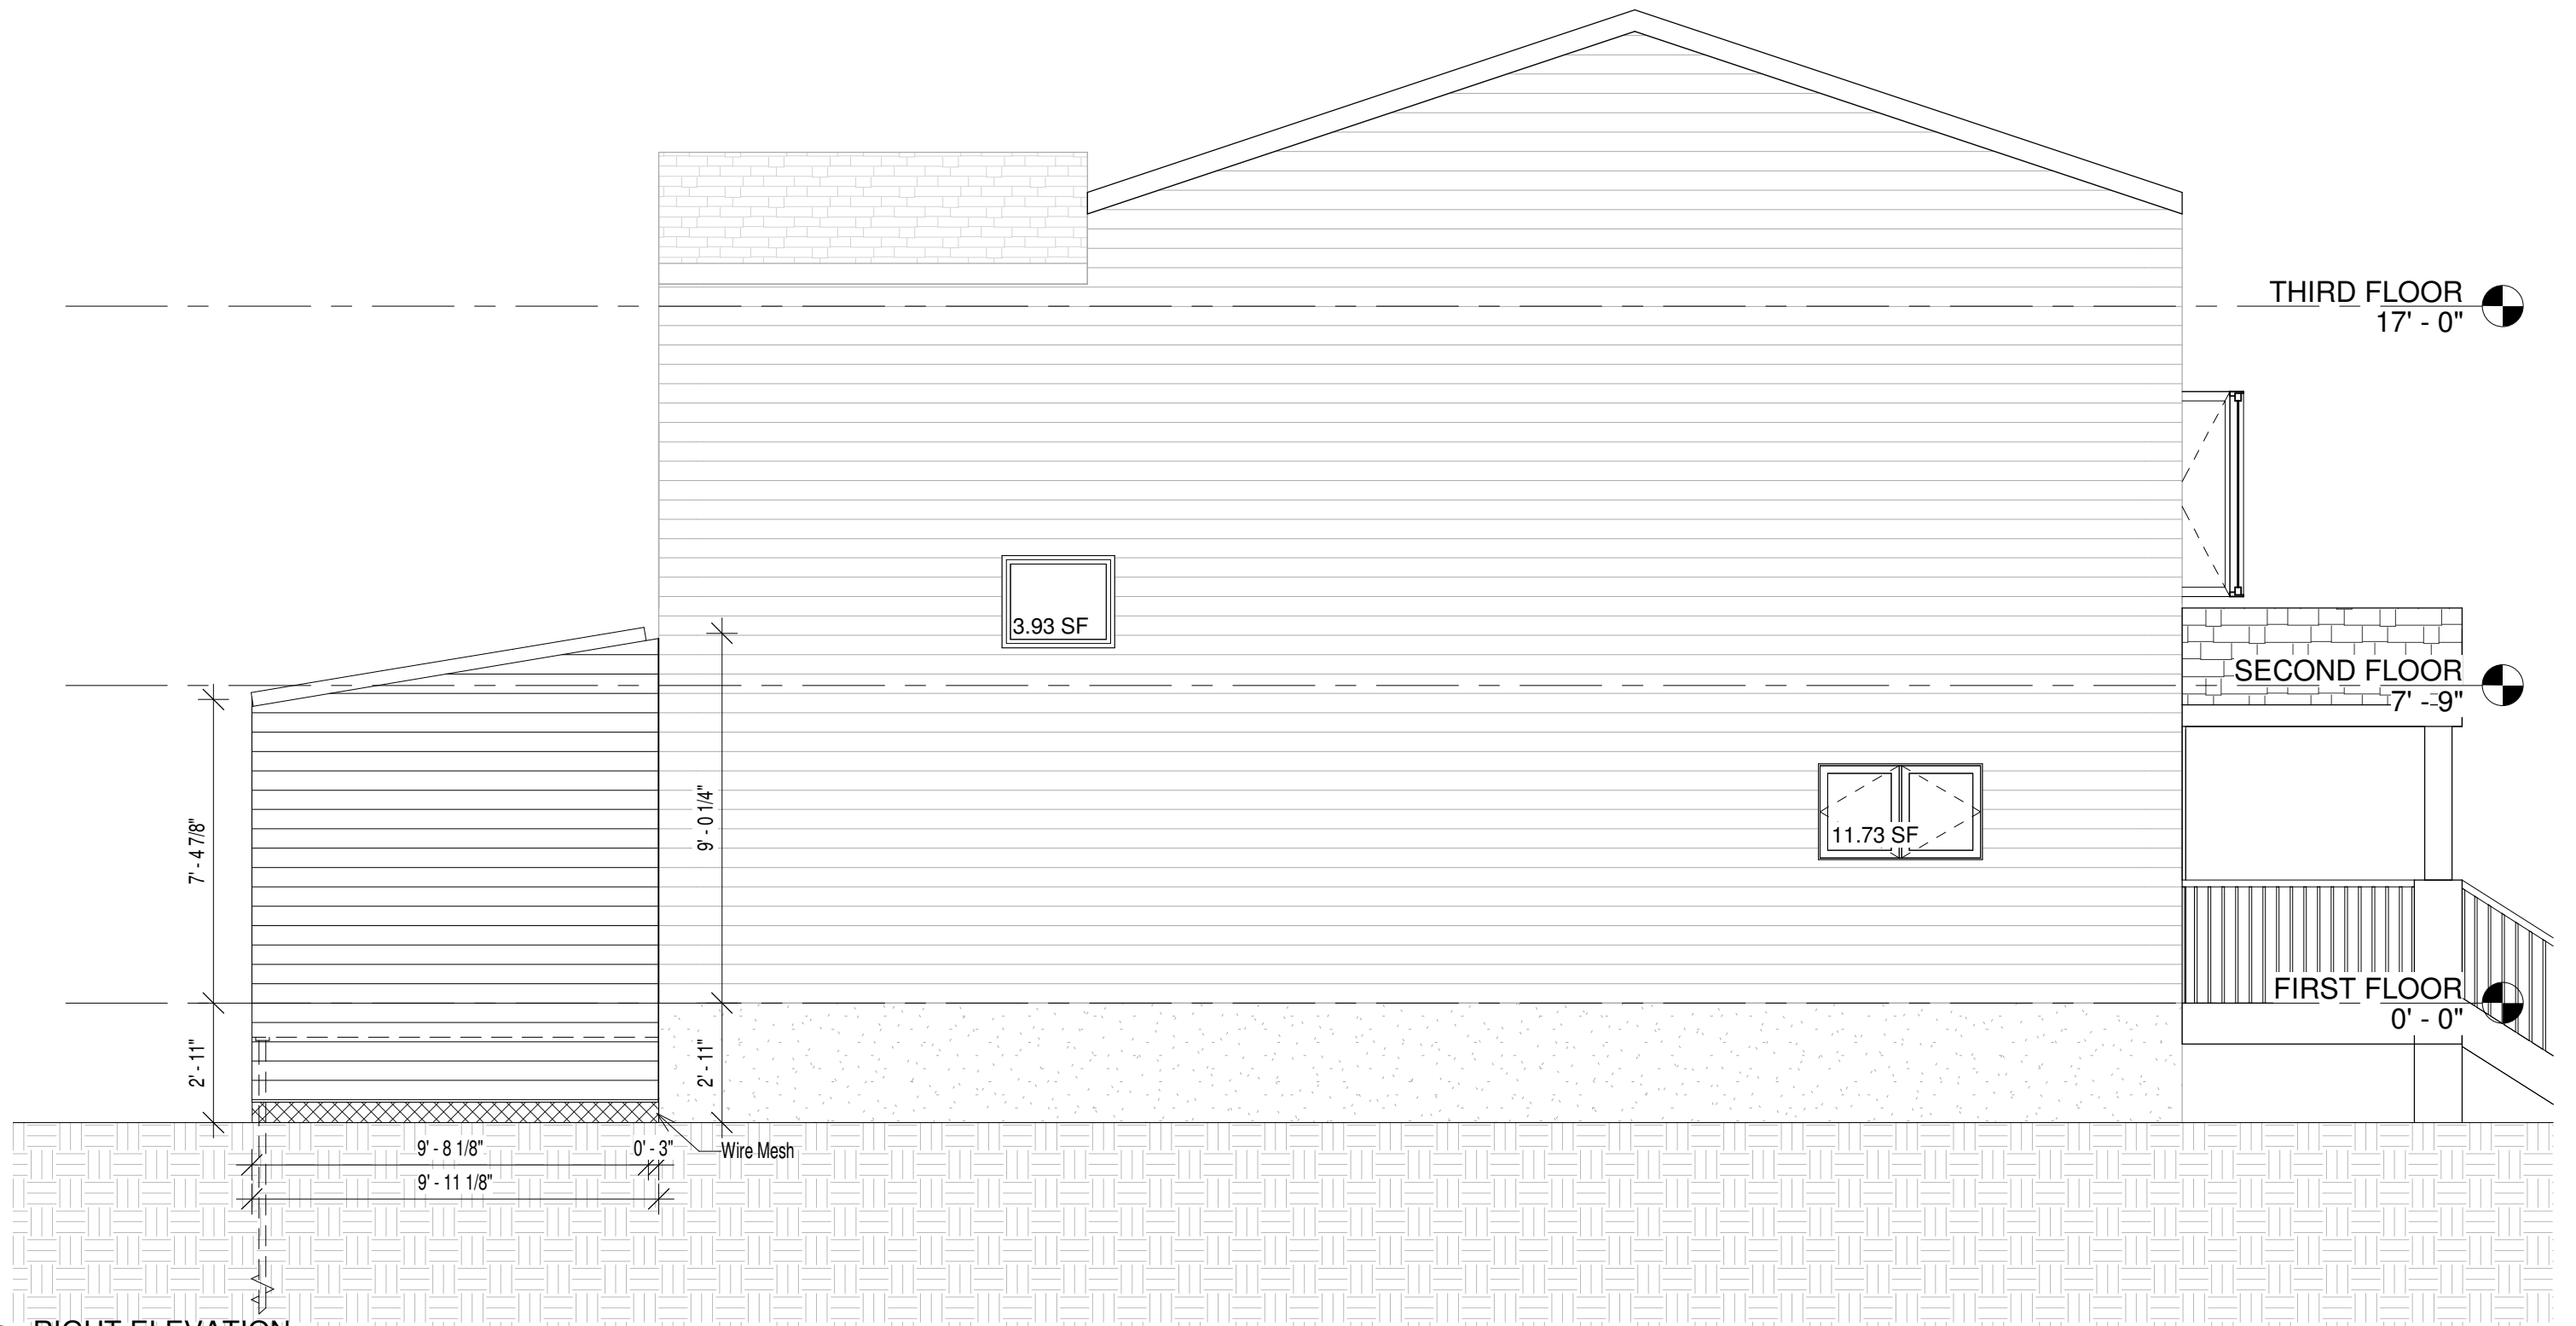

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| No. | Description | Date |
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### RIGHT ELEVATION

|                |                |
|----------------|----------------|
| Project number | Project Number |
| Date           | 2020.12.15     |
| Drawn by       | Author         |
| Checked by     | Checker        |

**A105**

Scale 1/4" = 1'-0"

# GLAZED OPENING CALCULATIONS

PER O.B.C TABLE 9.10.15.4

## Front Elevation


| # | WIDTH    | DEPTH | WINDOW/DOOR<br>FRAME SIZE(S.F) |
|---|----------|-------|--------------------------------|
| 1 | Existing |       | 43.35                          |
| 2 | New      |       | 28.32                          |

## Spatial Calculations

|                        |        |      |
|------------------------|--------|------|
| Exposing Building Face | 972.12 | S.F. |
|                        | 90.31  | S.M. |

## Portion Wall Area

|                   |       |      |
|-------------------|-------|------|
| Limiting Distance |       | 3'   |
| Max. % Openings   | 0     | %    |
| Openings Allowed  | 0     | S.F. |
| Openings provided | 71.67 | S.F. |

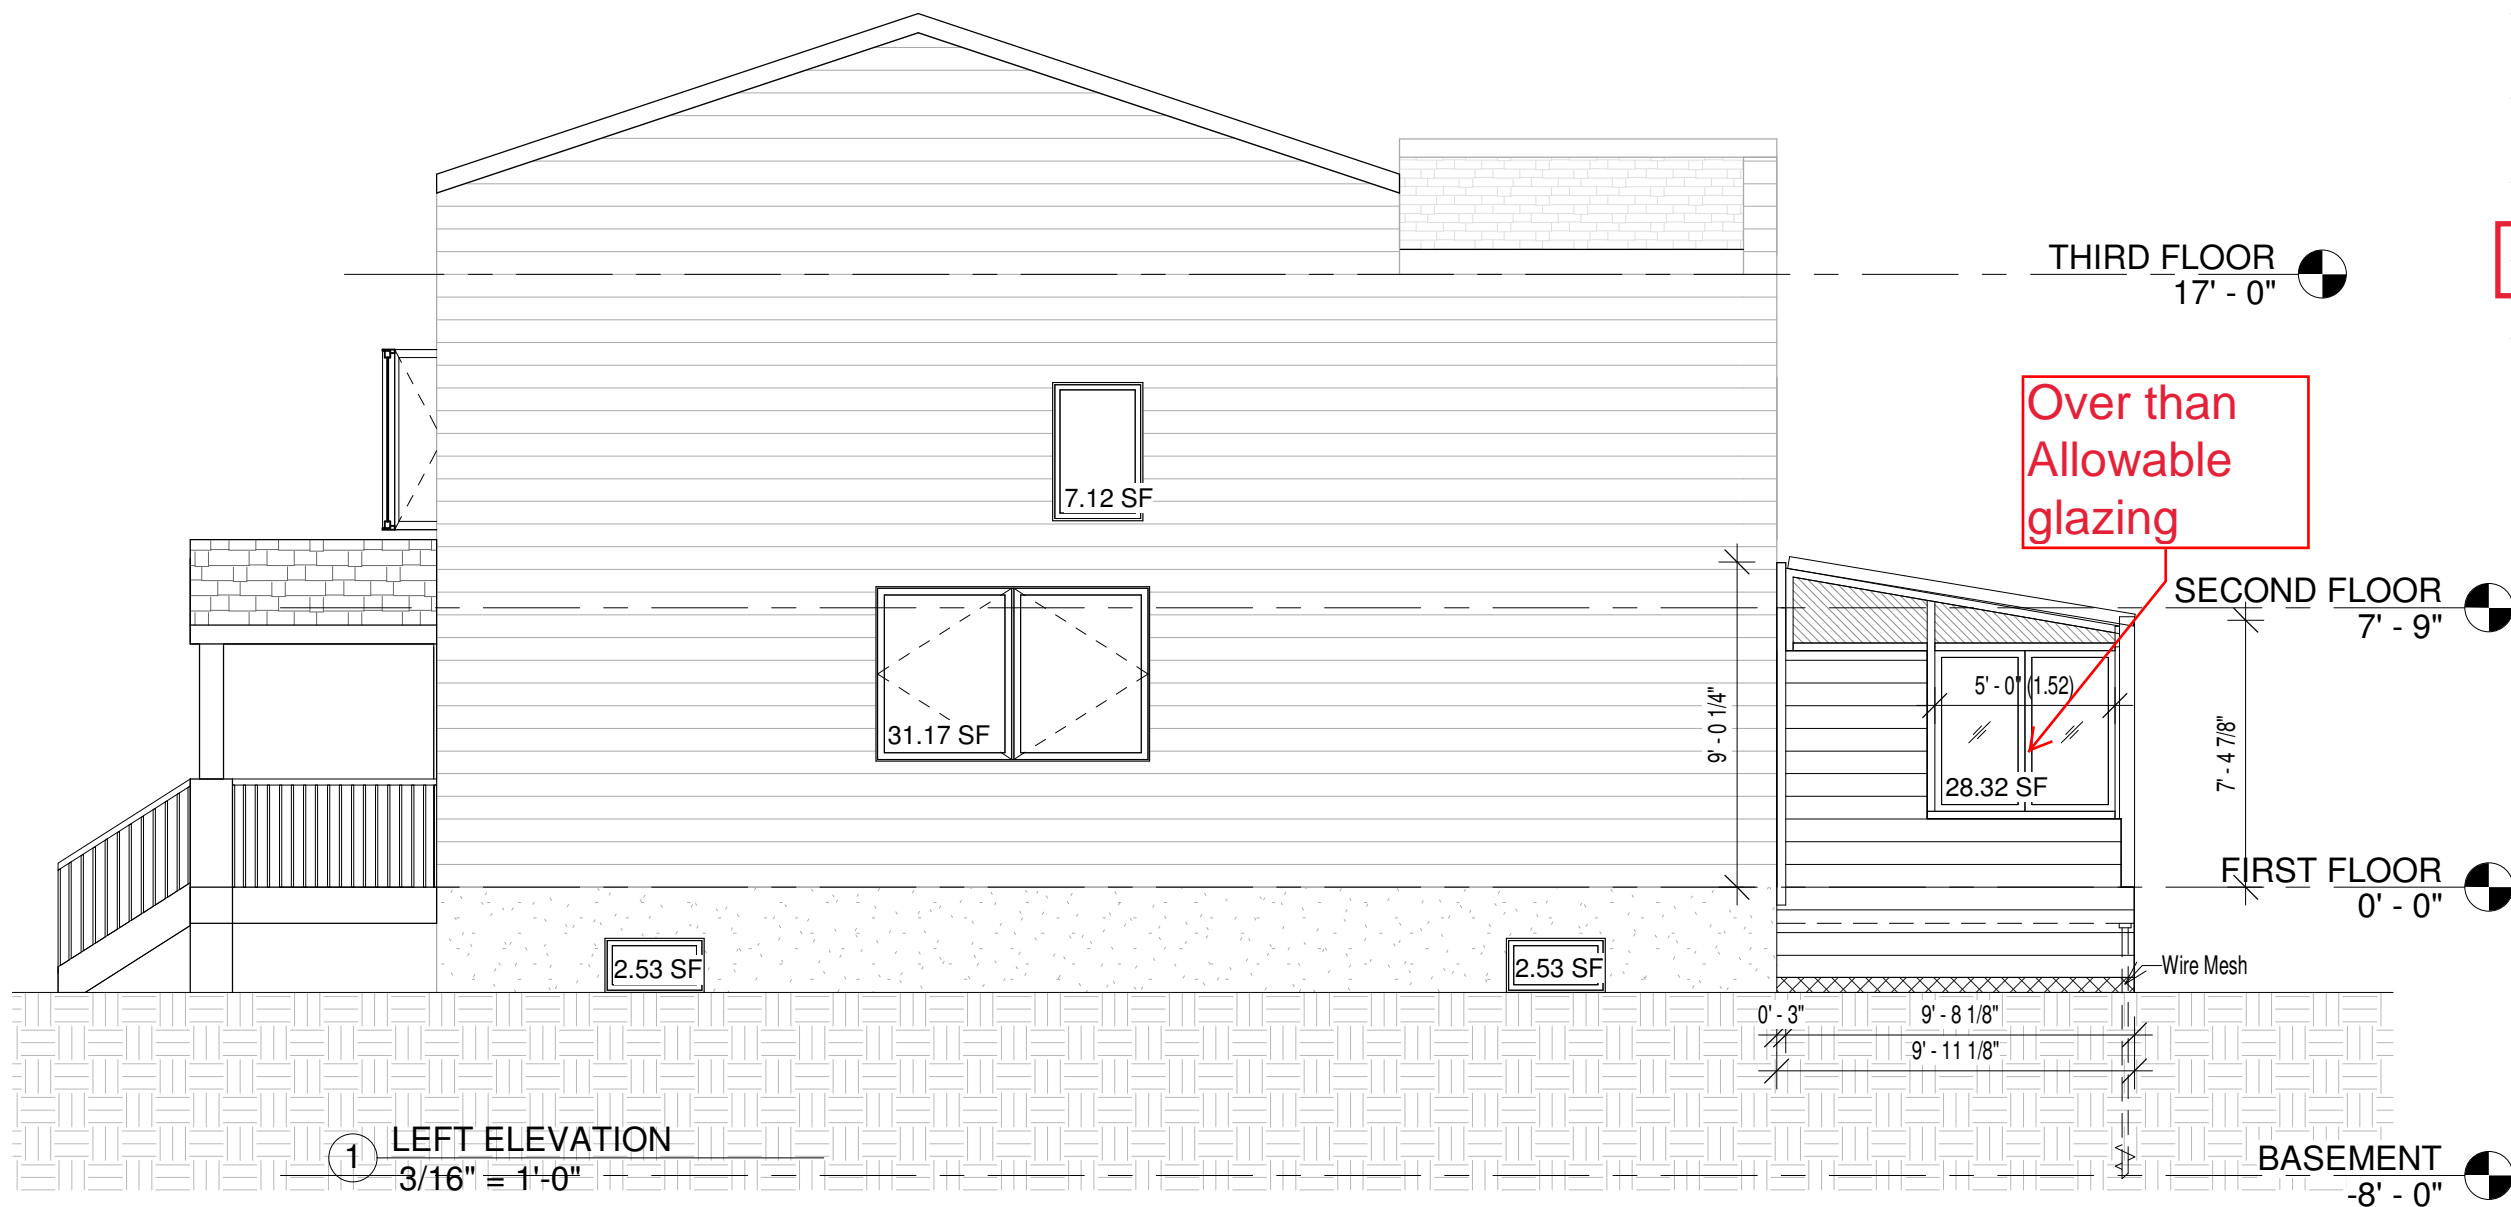

Over than Allowable glazing

Please go to next page for proposed Left Elevation.




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## LEFT ELEVATION

|                     |                |             |
|---------------------|----------------|-------------|
| Project number      | Project Number | <b>A106</b> |
| Date                | 2020.12.15     |             |
| Drawn by            | Author         |             |
| Checked by          | Checker        |             |
| Scale 3/16" = 1'-0" |                |             |



① LEFT ELEVATION  
1/4" = 1'-0"

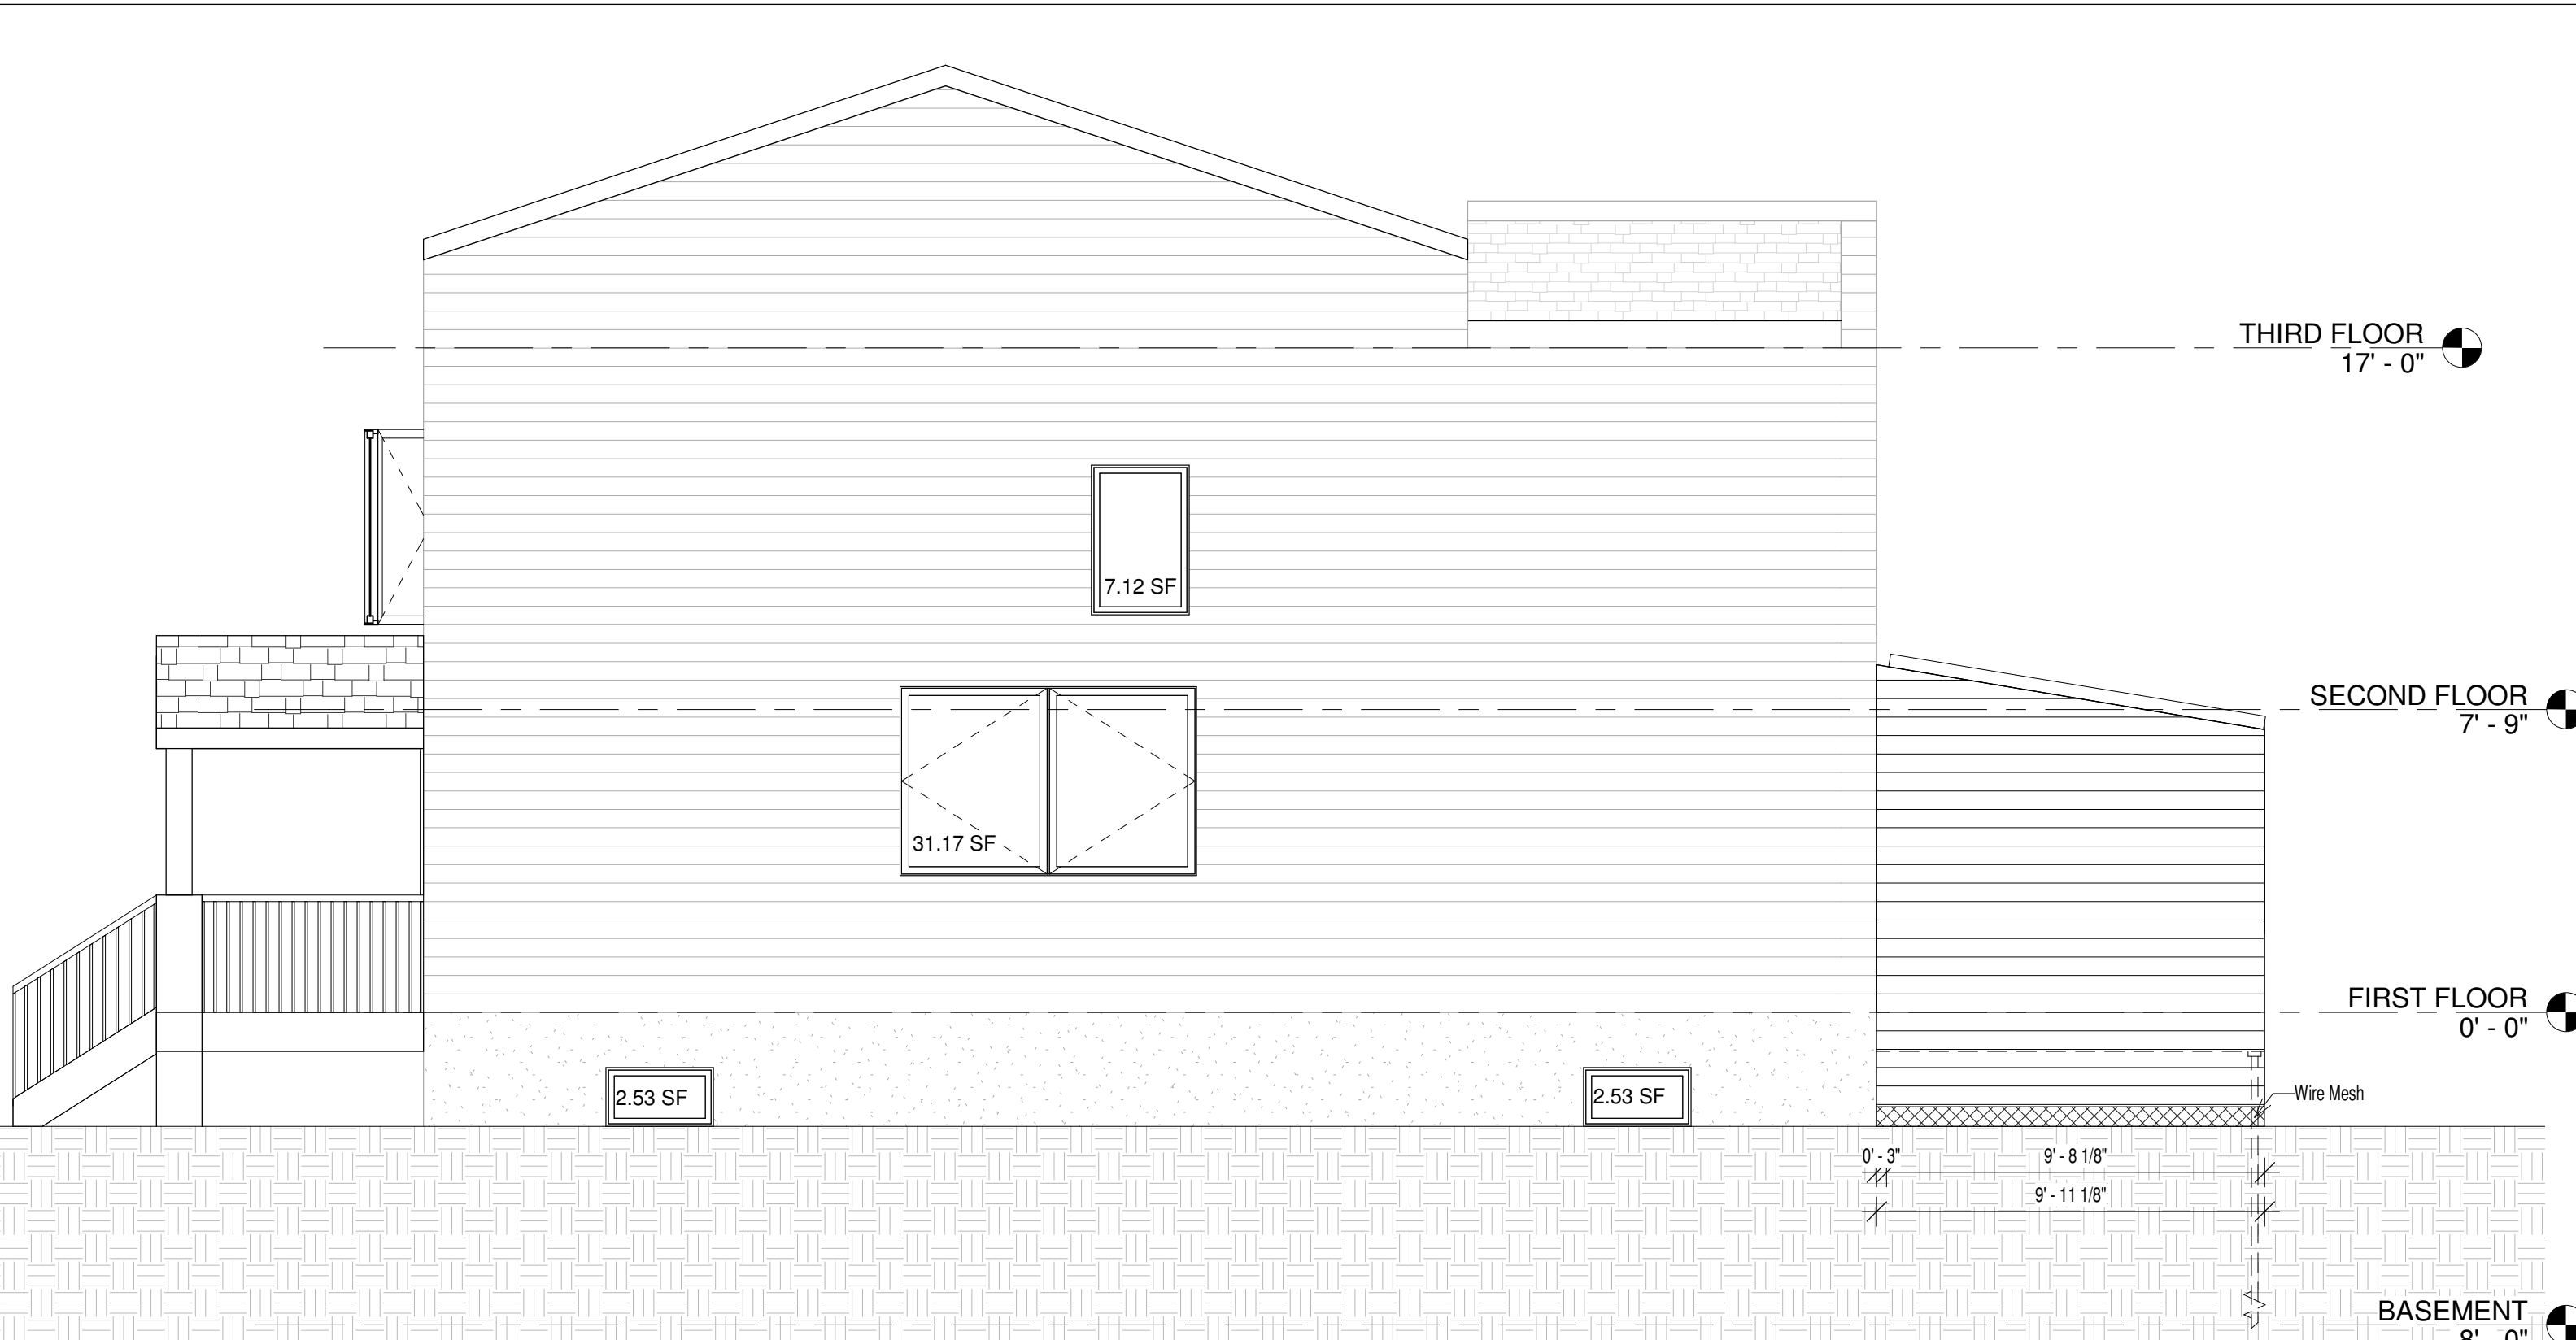


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| LEFT ELEVATION     |                |             |
|--------------------|----------------|-------------|
| Project number     | Project Number | <b>A106</b> |
| Date               | 2020.12.15     |             |
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| Checked by         | Checker        |             |
| Scale 1/4" = 1'-0" |                |             |





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 2x12 FLOOR JOIST @ 16" O.C.  
 R 39 INSULATION / VAPOUR BARRIER  
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 ALL JOISTS WITH BRIDGING @ MAX. 6'-11"  
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- 3 **VERTICAL GLAZING**  
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 PROTECTIVE GLASS MASKING
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 ALUM. FLASHINGS @ SILICONE SEALANT AT RIDGE MIN. 0.48mm  
 THICK ALUM. COATED FLASHING SEAL AT SUNROOM RIDGE

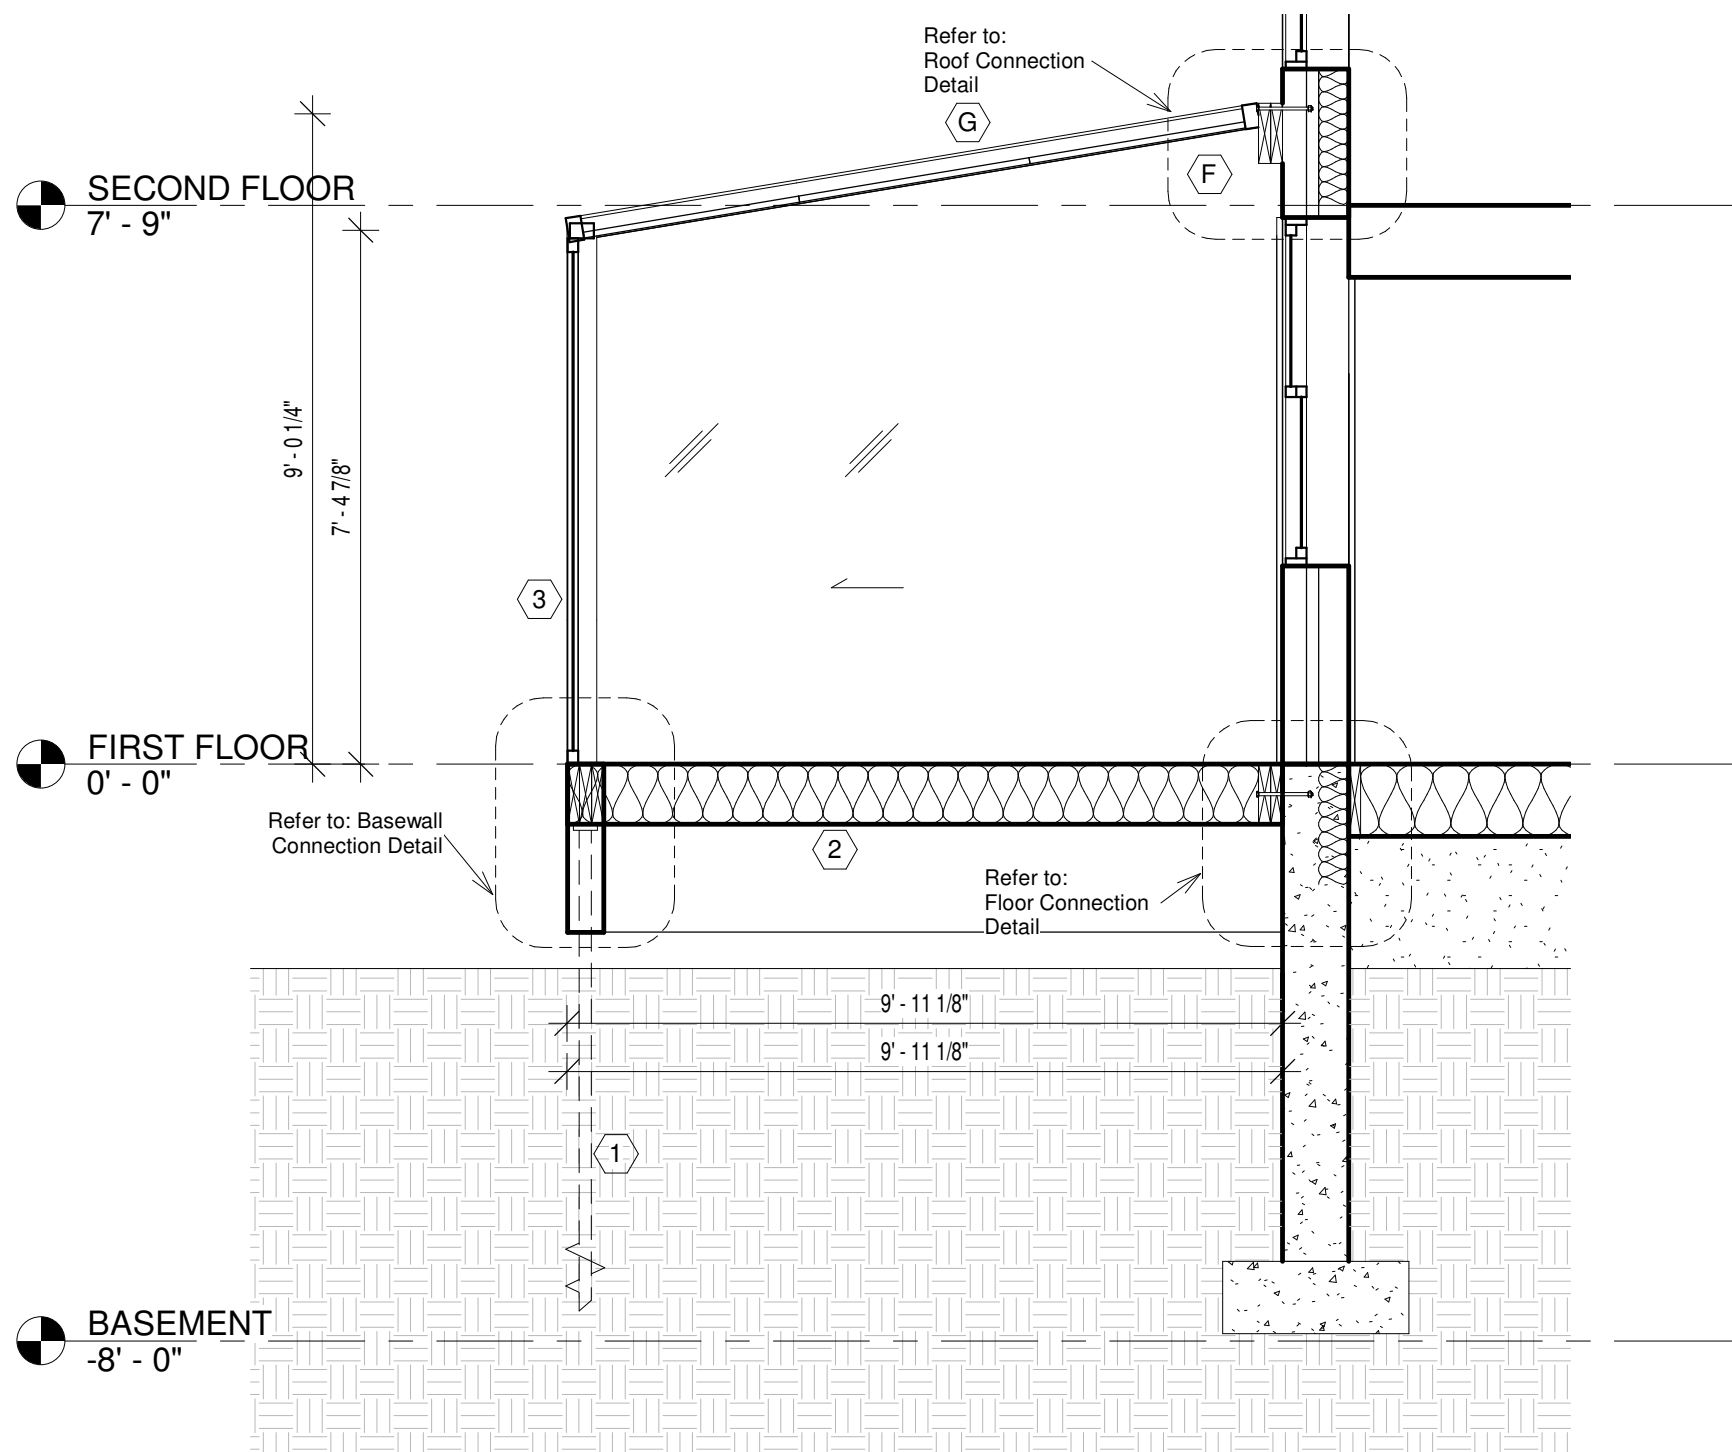
1 Section 1  
3/8" = 1'-0"



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| SECTION        |                |              |
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| Project number | Project Number | <b>A107</b>  |
| Date           | 2020.12.15     |              |
| Drawn by       | Author         |              |
| Checked by     | Checker        |              |
| Scale          |                | 3/8" = 1'-0" |




① TOP OF MAIN FLOOR Copy 1  
1/4" = 1'-0"

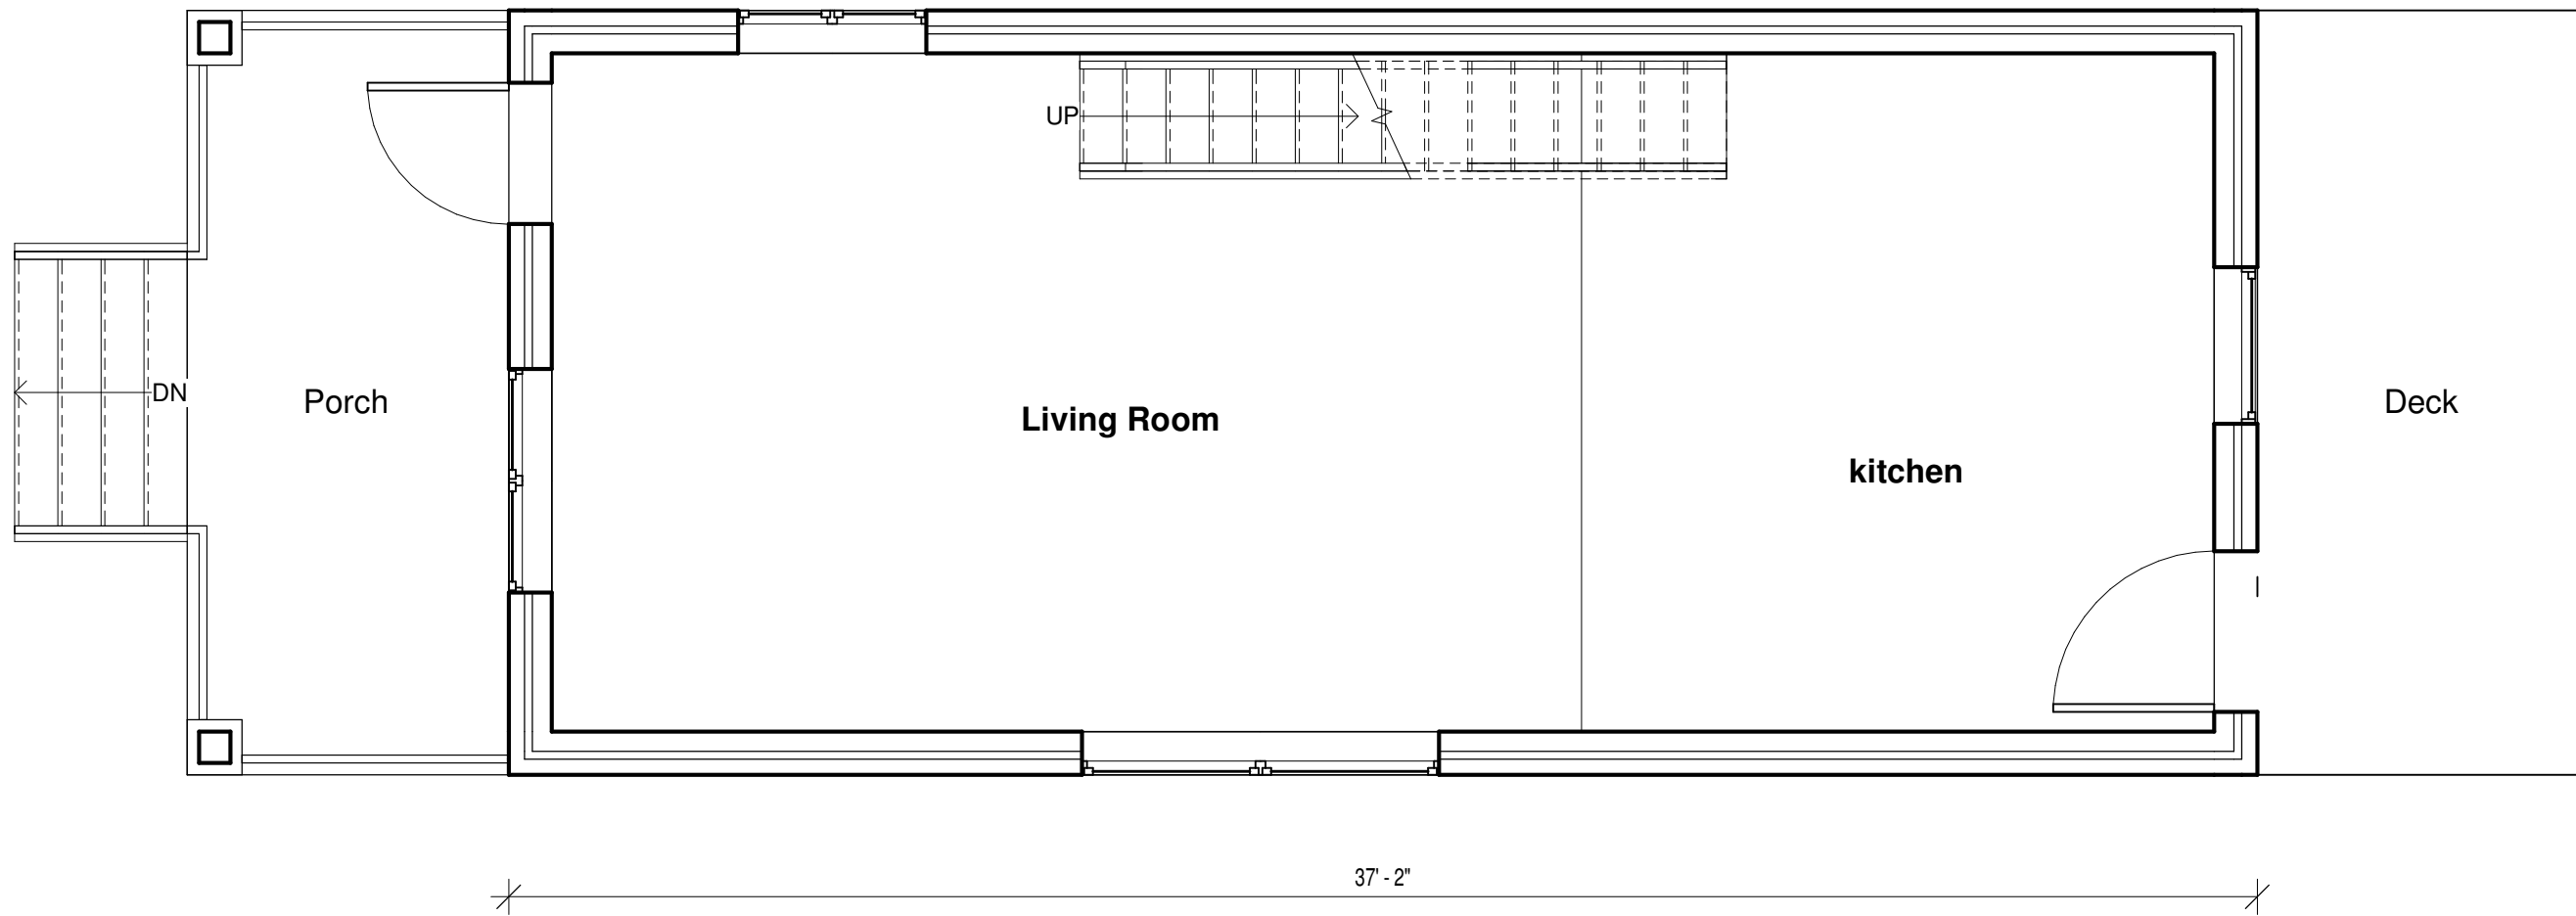

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| No. | Description | Date |
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| EXISTING FLOOR PLAN |                |                    |
|---------------------|----------------|--------------------|
| Project number      | Project Number | <b>A108</b>        |
| Date                | 2020.12.15     |                    |
| Drawn by            | Author         |                    |
| Checked by          | Checker        |                    |
|                     |                | Scale 1/4" = 1'-0" |



① SECOND FLOOR  
1/4" = 1'-0"

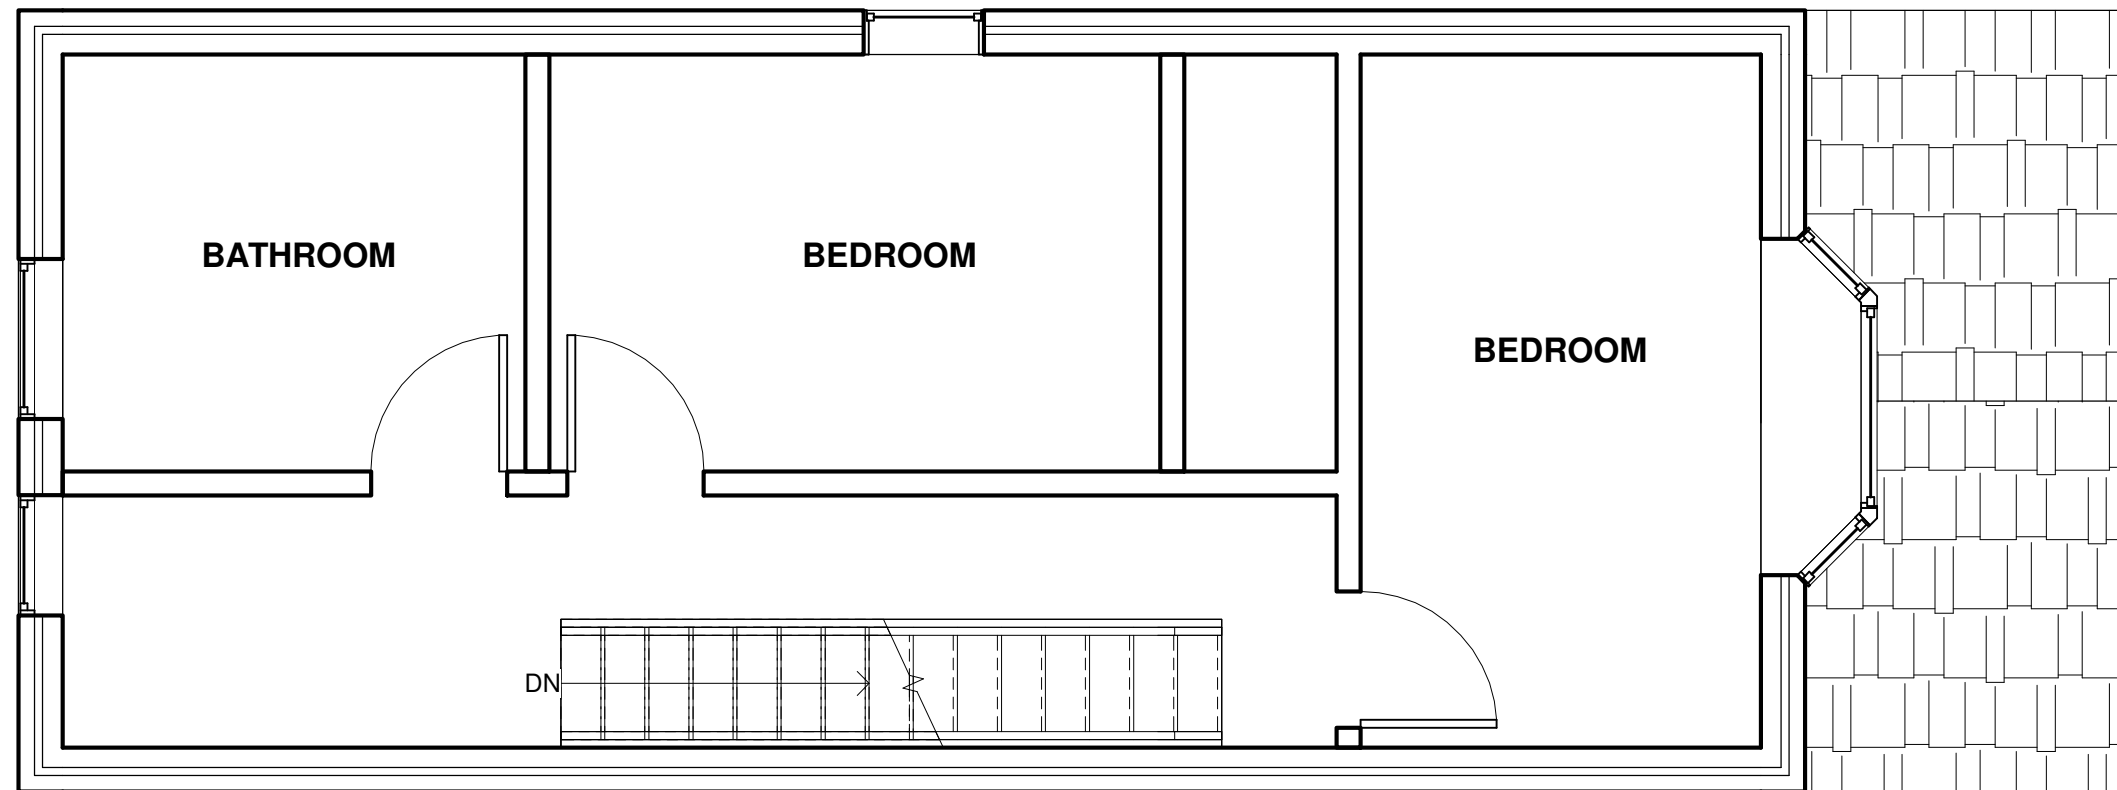

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| EXISTING FLOOR PLAN 2 |                |             |
|-----------------------|----------------|-------------|
| Project number        | Project Number | <b>A109</b> |
| Date                  | 2020.12.15     |             |
| Drawn by              | Author         |             |
| Checked by            | Checker        |             |
| Scale 1/4" = 1'-0"    |                |             |